

SECOND AMENDMENT TO
CONDOMINIUM DECLARATION FOR
COTTAGES AT SOUTHFORK CONDOMINIUM

***** COPY *****
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4/28/2009 4:12:01 PM

STATE OF LOUISIANA

PARISH OF EAST BATON ROUGE

FILED AND RECORDED
EAST BATON ROUGE PARISH, LA
DOUG WELBORN
CLERK OF COURT AND RECORDER

WHEREAS, the Condominium Declaration for Cottages at Southfork Condominium (the "Original Declaration") dated July 10, 2007, executed by The Cottages at Southfork, L.L.C., as Declarant ("Declarant"), was duly recorded in the official records of East Baton Rouge Parish, Louisiana, in Original 7, Bundle 11973, on July 11, 2007;

WHEREAS, the Original Declaration was amended by that certain First Amendment to Condominium Declaration for Cottages at Southfork Condominium (the "First Amendment"), dated February 16, 2009, executed by the Declarant, and duly recorded in the official records of East Baton Rouge Parish, Louisiana, in Original 408, Bundle 12126 on February 18, 2009 (collectively, the Original Declaration and the First Amendment, hereinafter referred to as the "Declaration");

WHEREAS, pursuant to Paragraph 8.2 of the Declaration, Declarant reserved the right to amend the Declaration for the purpose of, *inter alia*, to correct and update square footages, construction specifications, and estimated Operating Budget; and

WHEREAS, the Declarant wishes to amend the Declaration and to update and clarify construction specifications, including a division of two certain buildings and modifications in floor plans of future construction, and to update and revise the estimated Initial Operating Budget for common area maintenance

NOW THEREFORE, Declarant does hereby amend the Declaration in the following particulars:

I. Building 7 and Building 9 have been newly configured and separated into two buildings each, 7A and 7B, and 9A and 9B, respectively. All references to the number of buildings included in the condominium Project shall be corrected to number thirteen (13) and not eleven (11), including but not limited to such references in the third and fourth "WHEREAS" paragraphs on page one of the Original Declaration, and all such references in the Articles of Incorporation and Bylaws of the Association.

II. As a result of the reconfiguration of buildings, Unit 66 and Unit 88 have been eliminated, resulting in a reduction of the total number of Units from 109 to 107. All references to the number of Units in the condominium Project shall be corrected from 109 to 107, including but not limited to such references in Section 2.2 of the Original Declaration, and all such references in the Articles of Incorporation and Bylaws of the Association.

III. In order to correct the site plan, building number and to revise certain Unit square footages, **Exhibit "B": The Plat Elevations and Floor Plans** is hereby amended and supplemented with the maps and architectural drawings attached here as **Supplemental Exhibit "B"**. To the extent there is any inconsistency or variation between the original Exhibit "B" and the Supplemental Exhibit "B", the Supplemental Exhibit "B" shall control.

IV. **Exhibit "E": Estimated Initial Operating Budget** is hereby amended and replaced in its entirety with the figures in the **Second Revised Exhibit "E"** attached hereto.

V. **Exhibit "F": Percent of Ownership** is hereby amended and replaced in its entirety to reflect the revised budget and the revised number of total Units in the **Revised Exhibit "F"** attached hereto.


All other terms, conditions and provisions of the Declaration unaffected hereby shall remain in full force and effect.

IN WITNESS WHEREOF, the Declarant has caused this instrument to be signed, sealed and delivered by it undersigned representative, duly authorized, this 28th day of April, 2009, in the presence of the undersigned Notary Public and competent witnesses.

WITNESSES:




Michelle D. Holland




Sharla A. Ducote


**THE COTTAGES AT SOUTHFORK,
L.L.C.**

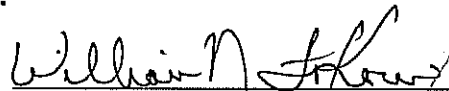By: 

William N. FaKouri, Manager

By: 

Jerry E. FaKouri, Manager



NOTARY PUBLIC
Joshua B. Zelden
Bar Roll #: 27150
My Commission Expires at death.

CERTIFICATE OF AUTHORITY
FOR
THE COTTAGES AT SOUTHFORK, L.L.C.

The undersigned, as the Certifying Officials of The Cottages at Southfork, L.L.C. (the "Company") and acting in such capacity, hereby certify that the Members of the Company have unanimously granted William N. FaKouri and Jerry E. FaKouri, as Managers of the Company (the "Managers") the authority to act for and on behalf of the Company as follows:

The Managers be and are hereby authorized and empowered on behalf of the Company to sign and execute the Second Amendment to Condominium Declaration for The Cottages at Southfork Condominium amending and revising the number of buildings and total Units, revising certain Unit square footages in the condominium Project, and replacing and revising Exhibit "B", Exhibit "E" and Exhibit "F.

The Managers be and are hereby authorized and empowered for and on behalf of the Company to execute the Second Amendment to Condominium Declaration for Cottages at Southfork Condominium and to execute any and all other documents necessary to carry out the authority granted in this Certificate.


CERTIFICATE

The undersigned duly designated Certifying Officials do hereby certify that William N. FaKouri, Inc. and Jerry E. FaKouri, Jr., Inc. are the only Members of The Cottages at Southfork, L.L.C. and that the foregoing Certificate of Authority has been duly adopted and approved by all Members of the Company.

THUS DONE AND SIGNED this 28th day of April, 2009.



William N. FaKouri, Certifying Official

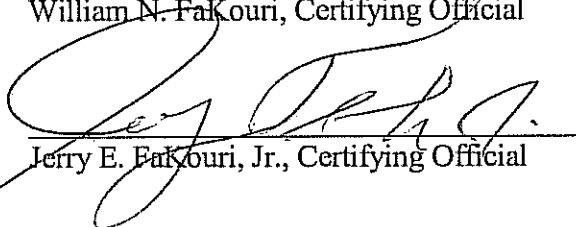


Jerry E. FaKouri, Jr., Certifying Official

VICINITY MAP

The Cottages @ Southfork Apartments

VICINITY MAP

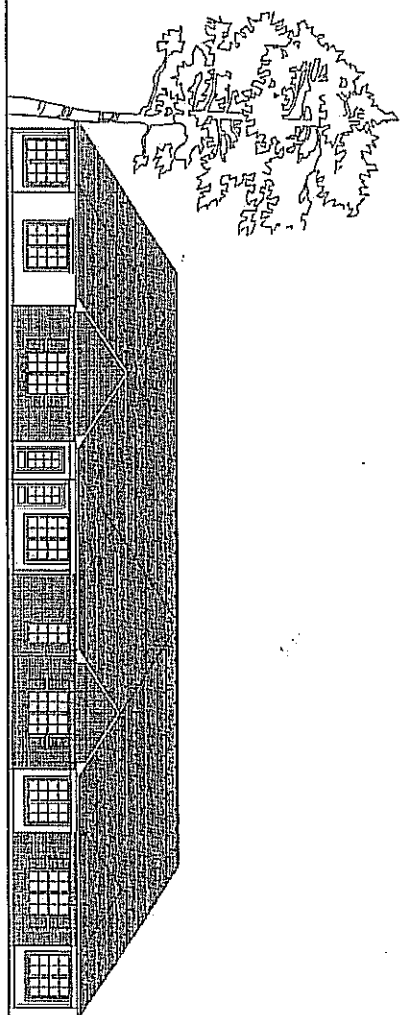

The Cottages at Southfork

11510 Southfork Drive, Baton Rouge, LA

| | | |
|--|--|--|
| <p>OWNER</p> <p>TOWER CAPITAL CORPORATION P.O. BOX 14151 BATON ROUGE, LOUISIANA 70899 PHONE: (225) 757-1110 FAX: (225) 757-1090</p> | <p>CONTRACTOR</p> <p>FAKOURI CONSTRUCTION BUILDER - JERRY FAKOURI, JR. 1875 DALLAS DRIVE BATON ROUGE, LOUISIANA 70806 PHONE: (225) 927-6220 FAX: (225) 627-3562</p> | <p>BUILDING DATA</p> <p>NO. OF UNITS: 10</p> <p>NO. OF STORIES: 3</p> <p>NO. OF FLOORS: 3</p> <p>NO. OF GARAGES: 10</p> <p>NO. OF PARKING SPACES: 10</p> <p>NO. OF STORAGE SPACES: 10</p> <p>NO. OF LOBBY AREAS: 1</p> <p>NO. OF COMMON AREAS: 1</p> <p>NO. OF MECHANICAL AREAS: 1</p> <p>NO. OF ELECTRICAL AREAS: 1</p> <p>NO. OF PLUMBING AREAS: 1</p> <p>NO. OF FIRE PROTECTION AREAS: 1</p> <p>NO. OF ELEVATOR AREAS: 1</p> <p>NO. OF STAIRWAYS: 1</p> <p>NO. OF ESCAPE ROUTES: 1</p> <p>NO. OF ENTRANCES: 1</p> <p>NO. OF EXITS: 1</p> <p>NO. OF STAIRS: 1</p> <p>NO. OF ELEVATORS: 1</p> <p>NO. OF GARAGES: 10</p> <p>NO. OF PARKING SPACES: 10</p> <p>NO. OF STORAGE SPACES: 10</p> <p>NO. OF LOBBY AREAS: 1</p> <p>NO. OF COMMON AREAS: 1</p> <p>NO. OF MECHANICAL AREAS: 1</p> <p>NO. OF ELECTRICAL AREAS: 1</p> <p>NO. OF PLUMBING AREAS: 1</p> <p>NO. OF FIRE PROTECTION AREAS: 1</p> <p>NO. OF ELEVATOR AREAS: 1</p> <p>NO. OF STAIRWAYS: 1</p> <p>NO. OF ESCAPE ROUTES: 1</p> <p>NO. OF ENTRANCES: 1</p> <p>NO. OF EXITS: 1</p> <p>NO. OF STAIRS: 1</p> <p>NO. OF ELEVATORS: 1</p> |
| <p>ARCHITECT</p> <p>THE ARCHITECTURAL STUDIO 408 NORTH SEVENTH STREET BATON ROUGE, LA 70802 (225) 315-1777 FAX: (225) 315-1776</p> | <p>SITE ENGINEER</p> <p>GWS ENGINEERING, INC. CONTACT: KAREN KENNEDY 7520 PERKINS RD STE 280 BATON ROUGE, LA 70805 (225) 785-1788 FAX: (225) 705-1954</p> | <p>CODE DATA</p> <p>REGULATORY CODE: ASHRAE 90.1-2010</p> <p>CONSTRUCTION CODE: IRC 2015</p> <p>MECHANICAL CODE: ASHRAE 62.1-2010</p> <p>ELECTRICAL CODE: NEC 2017</p> <p>PLUMBING CODE: UPC 2015</p> <p>FIRE PROTECTION CODE: NFPA 101</p> <p>ELEVATOR CODE: ASME A17.1-2013</p> <p>STAIRWAYS CODE: IBC 1010</p> <p>ESCAPE ROUTES CODE: IBC 1030</p> <p>ENTRANCES CODE: IBC 1020</p> <p>EXITS CODE: IBC 1030</p> <p>STAIRS CODE: IBC 1030</p> <p>ELEVATORS CODE: ASME A17.1-2013</p> |

| No. | Sheet No. | Description |
|-----|-----------|----------------------|
| 1 | 1 | COVER SHEET |
| 2 | 2 | GENERAL NOTES |
| 3 | 3 | FOUNDATION PLAN |
| 4 | 4 | FLOOR PLAN |
| 5 | 5 | ROOF PLAN |
| 6 | 6 | MECHANICAL PLAN |
| 7 | 7 | ELECTRICAL PLAN |
| 8 | 8 | PLUMBING PLAN |
| 9 | 9 | FIRE PROTECTION PLAN |
| 10 | 10 | ELEVATOR PLAN |
| 11 | 11 | STAIRWAY PLAN |
| 12 | 12 | ESCAPE ROUTE PLAN |
| 13 | 13 | ENTRANCE PLAN |
| 14 | 14 | EXIT PLAN |
| 15 | 15 | STAIR PLAN |
| 16 | 16 | ELEVATOR PLAN |
| 17 | 17 | MECHANICAL PLAN |
| 18 | 18 | ELECTRICAL PLAN |
| 19 | 19 | PLUMBING PLAN |
| 20 | 20 | FIRE PROTECTION PLAN |
| 21 | 21 | ELEVATOR PLAN |
| 22 | 22 | STAIRWAY PLAN |
| 23 | 23 | ESCAPE ROUTE PLAN |
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| 26 | 26 | STAIR PLAN |
| 27 | 27 | ELEVATOR PLAN |
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| 34 | 34 | ESCAPE ROUTE PLAN |
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| 46 | 46 | ENTRANCE PLAN |
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| 97 | 97 | FIRE PROTECTION PLAN |
| 98 | 98 | ELEVATOR PLAN |
| 99 | 99 | STAIRWAY PLAN |
| 100 | 100 | ESCAPE ROUTE PLAN |

The Architectural Studio
ARCHITECTURAL ARCHITECTURAL ARCHITECTURE

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jadd@archstudio.com

GENERAL NOTES:
1. ALL DIMENSIONS ARE TO FACE UNLESS OTHERWISE NOTED.
2. FINISHES ARE TO BE DETERMINED BY THE ARCHITECT.
3. ALL WORK IS TO BE IN ACCORDANCE WITH THE LATEST EDITIONS OF THE INTERNATIONAL BUILDING CODES AND ALL APPLICABLE LOCAL ORDINANCES.
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5. THE CONTRACTOR SHALL BE RESPONSIBLE FOR PROTECTING ALL EXISTING UTILITIES AND STRUCTURES.
6. THE CONTRACTOR SHALL BE RESPONSIBLE FOR MAINTAINING ACCESS TO ALL ADJACENT PROPERTIES AND PUBLIC UTILITIES.
7. THE CONTRACTOR SHALL BE RESPONSIBLE FOR PROTECTING ALL EXISTING TREES AND LANDSCAPE.
8. THE CONTRACTOR SHALL BE RESPONSIBLE FOR MAINTAINING ALL NECESSARY RECORDS AND AS-BUILT DRAWINGS.







NOTE:
GROSS AREAS TAKEN TO OUTSIDE FACE OF STUD WALL.
NET AREAS TAKEN TO INSIDE FACE OF EXTERIOR STUD WALL.

The Cottages @ Southfork Apartments
1110 Southfork Street
Baton Rouge, Louisiana
Priced Construction Company

DATE: 11/11/2023
PROJECT: 2023
DRAWING NO.:
DATE: 11/11/2023

SCALE: 1/8" = 1'-0"
SHEET NO. 3
TOTAL SHEETS: 22

| Grid | Building Type | Unit | Area (S.F.) | Other Info |
|-------|---|------|---|-------------|
| 1-4 | Type 1 4 Buildings on Site (Buildings 1, 5, 10 & 11) | | 14,120 S.F. TOTAL BUILDING AREA (including parking and program) TOTAL COOLED AREA | 19,304 S.F. |
| 5-9 | Type 2 3 Buildings on Site (Buildings 3, 6, & 8) | | 22,103 S.F. TOTAL BUILDING AREA (including parking and program) TOTAL COOLED AREA | 14,722 S.F. |
| 10-15 | Type 3 1 Building on Site (Building 4) | | 30,172 S.F. TOTAL BUILDING AREA (including parking and program) TOTAL COOLED AREA | 20,119 S.F. |
| 16-19 | Type 4 1 Building on Site (Building 2) | | 14,687 S.F. TOTAL BUILDING AREA (including parking and program) TOTAL COOLED AREA | 9,389 S.F. |
| 20-23 | Type 5 3 Buildings on Site (Building 7A, 7B & 9A) | | 7,295 S.F. TOTAL BUILDING AREA (including parking and program) TOTAL COOLED AREA | 6,272 S.F. |
| 1 | J1 Building Type 1 | | | |
| 5 | J6 Building Type 2 | | | |
| 10 | J12 Building Type 3 | | | |
| 16 | J18 Building Type 4 | | | |
| 20 | J20 Building Type 5 | | | |
| 1 | A1 Building Type 6 | | | |
| 5 | A5 Unit A | | | |
| 9 | A8 Unit C | | | |
| 13 | A12 Unit D | | | |
| 17 | A16 Unit F | | | |
| 21 | A20 Unit G | | | |

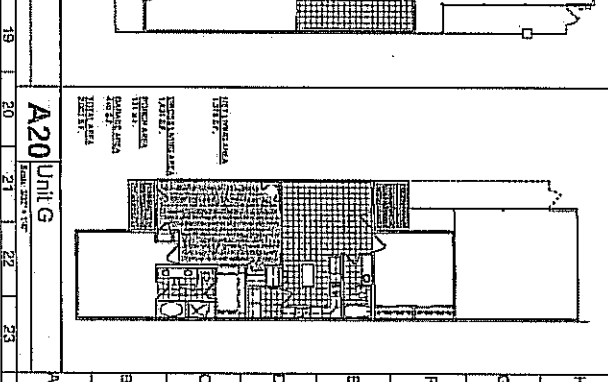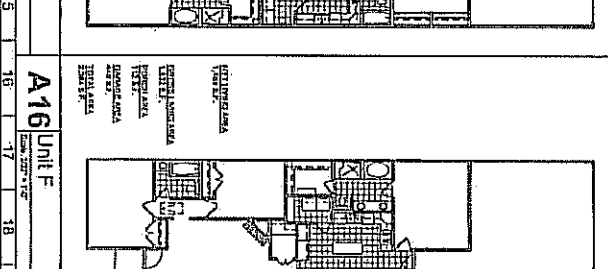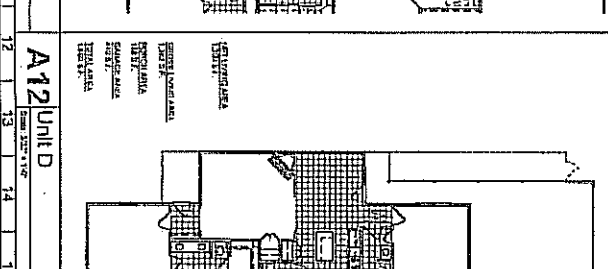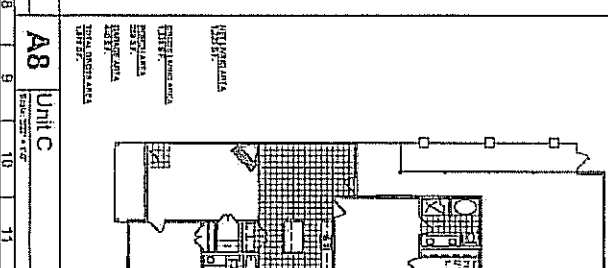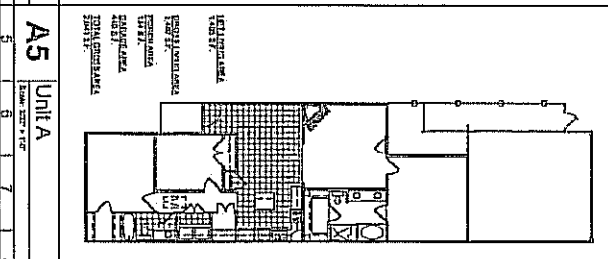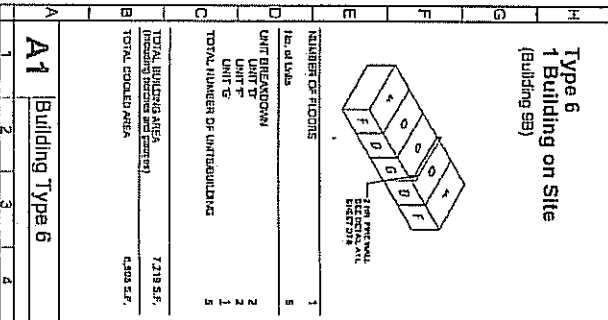

NUMBERS OF FLOORS
1


UNIT BREAKDOWN
UNIT A: 2
UNIT C: 1
UNIT D: 1

TOTAL NUMBER OF UNITS/BUILDING
5

TOTAL BUILDING AREA (including parking and program)
7,219 S.F.

TOTAL COOLED AREA
6,903 S.F.

VERTICAL SIGNING ON ALL REAR WALLS INCLUDING INSIDE OF GARAGE, OUTSIDE OF GARAGE, AND PORCHES AS NOTED ON UNIT PLANS

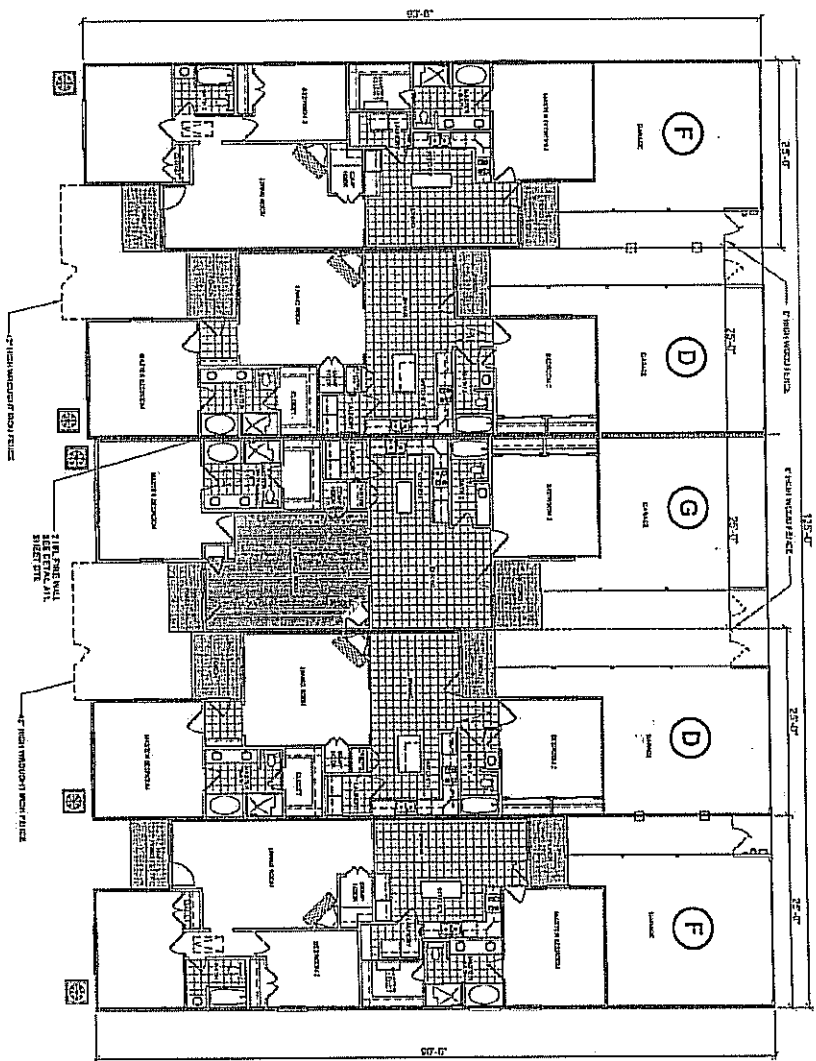

E1 Building Type 6 - Floor Plan

| UNIT | UNIT F | UNIT G | UNIT D |
|-------------|------------|------------|------------|
| LIVING AREA | 1,232 S.F. | 1,431 S.F. | 1,202 S.F. |
| PORCHES | 112 S.F. | 131 S.F. | 151 S.F. |
| GARAGE | 440 S.F. | 440 S.F. | 440 S.F. |
| TOT. AREA | 2,084 S.F. | 2,002 S.F. | 1,993 S.F. |


NOTE: AREAS TAKEN TO OUTSIDE FACE OF PERIMETER STUD WALL

A1 GENERAL NOTES

INDICATES FIRE RATED WALL (1 HOUR)

A6 Unit Areas

A14 Building Composition

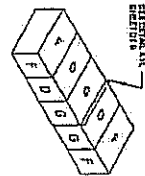

TOTAL NUMBER OF TYPE 6 UNITS: 1

A19 Bldg. Type 6 - Breakdown

| NUMBER OF FLOORS | 1 |
|---|-------------|
| LIFT BREAKDOWN | 2 |
| UNIT F | 1 |
| UNIT G | 1 |
| UNIT D | 5 |
| TOTAL LIVING AREA (GROSS - INCLUDING DECKS AND TERRACE) | 10,093 S.F. |

B6.1

PROJECT: B6.1
 SHEET TITLE: BUILDING TYPE 6 - FLOOR PLAN
 DATE: 01/12/2010


The Cottages @ Southfork Apartments

11610 Southfork Street
 Baton Rouge, Louisiana
 Fabcon Construction Company

PROJECT NO. 2223
 REV. 2010.01.11
 DRAWN BY: [Signature]

The Architectural Studio
 A PROFESSIONAL ARCHITECTURAL FIRM
 JAMES D. DODDS
 ARCHITECT
 C. DALE HOWARD
 ARCHITECT
 410 Main Street
 Baton Rouge, LA 70802
 (225) 765-1777
 info@archstudio.com


NOTICE TO THE PUBLIC
 This is a preliminary drawing and does not represent a contract. It is subject to change without notice. It is not to be used for construction. It is not to be used for any other purpose without the written consent of the Architect. The Architect is not responsible for the accuracy of the information provided by the client. The Architect is not responsible for the accuracy of the information provided by the client. The Architect is not responsible for the accuracy of the information provided by the client.

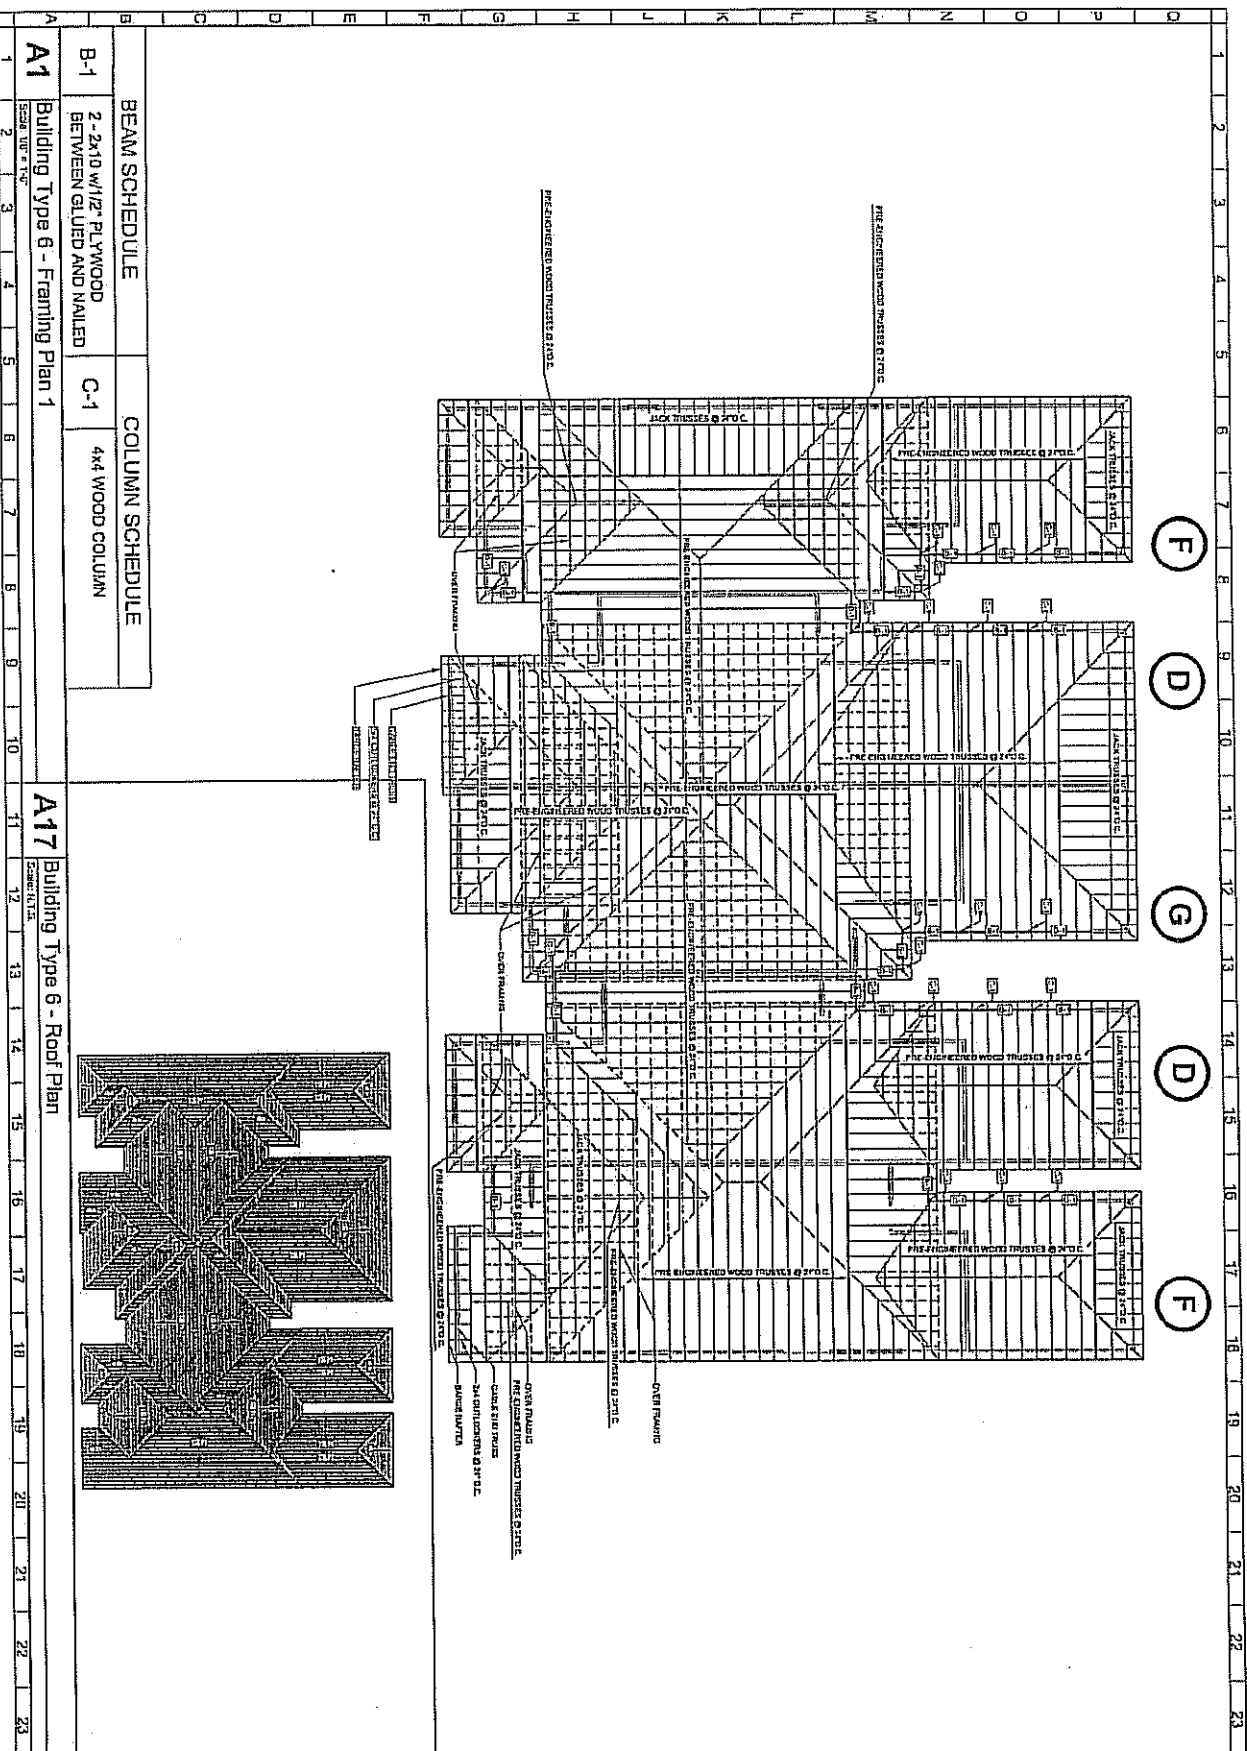

| | | | |
|---------------|--|-----------------|-----------------|
| BEAM SCHEDULE | | COLUMN SCHEDULE | |
| B-1 | 2-2x10 w/1/2" PLYWOOD BETWEEN GLUED AND NAILED | C-1 | 4x4 WOOD COLUMN |

A1 Building Type 6 - Framing Plan 1
Scale: 1/8" = 1'-0"

A17 Building Type 6 - Roof Plan
Scale: 1/16" = 1'-0"

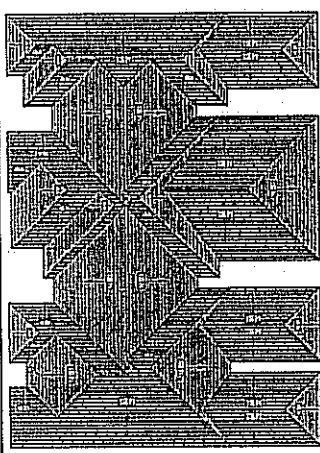

The
Architectural Studio
A PROFESSIONAL ARCHITECTURAL CORPORATION

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GENERAL NOTES:
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4. THE CONTRACTOR SHALL BE RESPONSIBLE FOR PROTECTING ALL EXISTING UTILITIES AND STRUCTURES.
5. THE CONTRACTOR SHALL MAINTAIN ADEQUATE RECORDS OF ALL WORK PERFORMED.

CONSTRUCTION DOCUMENTS


The Cottages @ Southfork Apartments

11810 Southfork Street
Bossier Rouge, Louisiana
Fidelity Construction Company


DATE: 10/10/2013
PROJECT: THE COTTAGES @ SOUTHFORK APARTMENTS
DRAWN BY: JBD




PROJECT TITLE: THE COTTAGES @ SOUTHFORK APARTMENTS
DATE: 10/10/2013
SCALE: 1/8" = 1'-0"

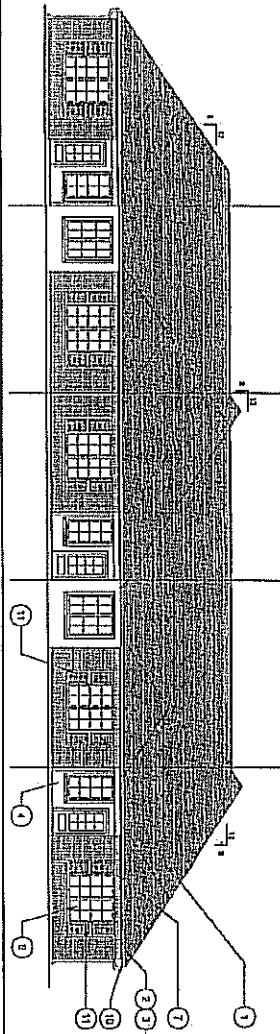


L1 Building Type 6 - Front Elevation
Scale: 1/8" = 1'-0"

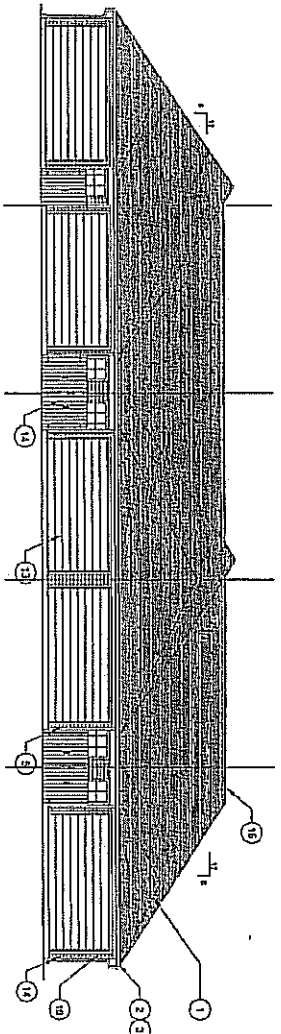

G1 Building Type 6 - Rear Elevation
Scale: 1/8" = 1'-0"

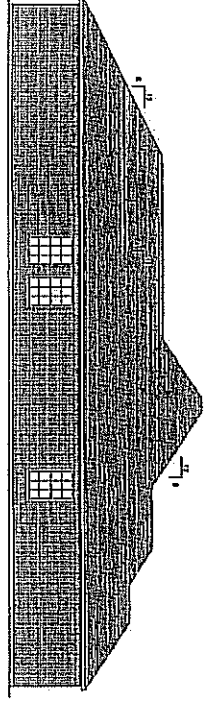

A1 Building Type 6 - Left Side Elevation
Scale: 1/8" = 1'-0"

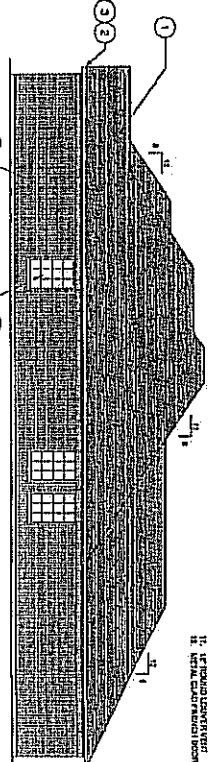

A12 Building Type 6 - Right Side Elevation
Scale: 1/8" = 1'-0"

1. TRUSS AND BRIDGE JOIST
2. CONCRETE SLAB ON TOP OF FOOTING
3. TRUSS AND BRIDGE JOIST
4. TRUSS AND BRIDGE JOIST
5. TRUSS AND BRIDGE JOIST
6. TRUSS AND BRIDGE JOIST
7. TRUSS AND BRIDGE JOIST
8. TRUSS AND BRIDGE JOIST
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17. TRUSS AND BRIDGE JOIST
18. TRUSS AND BRIDGE JOIST
19. TRUSS AND BRIDGE JOIST

The
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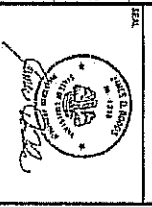
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CONSTRUCTION DOCUMENTS

The Cottages @ Southfork

Apartment
11510 Southfork Street
Baton Rouge, Louisiana
Fidelity Construction Company

PROJ. NO. 2010-001
FILE NO. 101
DATE: 10/1/10



PROJECT TITLE
BUILDING TYPE 6
DRAWING NO. **B6.4**
DATE: 10/1/10

Cottages at Southfork Condominium Association

ESTIMATED OPERATING BUDGET 2008-2009

| <u>Category</u> | <u>Budgeted Cost Per Year</u> | <u>Per Month</u> | <u>Per Unit Month</u> |
|-----------------------------------|-------------------------------|----------------------------|-------------------------|
| Accounting | \$ 2,400.00 | \$ 200.00 | \$ 1.83 |
| Bank Charges | \$ 600.00 | \$ 50.00 | \$ 0.46 |
| Cable Television | \$ 55,590.00 | \$ 4,632.50 | \$ 42.50 |
| Common Area Maintenance | \$ 3,000.00 | \$ 250.00 | \$ 2.29 |
| Electricity | \$ 13,000.00 | \$ 1,083.33 | \$ 9.94 |
| Fire, Hazard, Liability Insurance | \$ 53,085.00 | \$ 4,423.75 | \$ 40.58 |
| Grounds Keeping & Landscape | \$ 18,000.00 | \$ 1,500.00 | \$ 13.76 |
| Legal Fees | \$ 1,500.00 | \$ 125.00 | \$ 1.15 |
| Management Fee | \$ 18,966.00 | \$ 1,580.50 | \$ 14.50 |
| Miscellaneous | \$ 6,000.00 | \$ 500.00 | \$ 4.59 |
| Pest Control | \$ 6,000.00 | \$ 500.00 | \$ 4.59 |
| Pool Maintenance | \$ 4,200.00 | \$ 350.00 | \$ 3.21 |
| Reserve Funds | \$ 20,915.00 | \$ 1,742.92 | \$ 15.99 |
| Water | \$ 2,400.00 | \$ 200.00 | \$ 1.83 |
| <u>Sub Total</u> | <u>\$ 205,656.00</u> | <u>\$ 17,138.00</u> | <u>\$ 157.23</u> |

| | | | | |
|-----------------------------------|----------------------|----------|---------------------------|------------------|
| Total Yearly Budget | \$ 205,656.00 | = | Per Unit Per Month | \$ 160.17 |
| Total Units in Association | 107 | | | |

Rounded to the nearest dollar **\$ 160.00**

**REVISED EXHIBIT "F" TO
CONDOMINIUM DECLARATION FOR
THE COTTAGES AT SOUTHFORK CONDOMINIUM**

PERCENT OF OWNERSHIP

| | <u>Unit Number</u> | <u>Unit Type</u> | <u>Square Footage</u> | <u>Percent Ownership**</u> |
|-------------|--------------------|------------------|-----------------------|----------------------------|
| Building 1: | 1 | 2 BdRm-D | 1300 | 0.90227% |
| | 2 | 2 BdRm-C | 1223 | 0.84885% |
| | 3 | 3 BdRm-A | 1405 | 0.97515% |
| | 4 | 2 BdRm-D | 1300 | 0.90227% |
| | 5 | 2 BdRm-C | 1223 | 0.84885% |
| | 6 | 3 BdRm-F | 1469 | 1.01957% |
| | 7 | 3 BdRm-A | 1405 | 0.97515% |
| | 8 | 3 BdRm-F | 1469 | 1.01957% |
| Building 2: | 9 | 3 BdRm-F | 1469 | 1.01957% |
| | 10 | 3 BdRm-F | 1469 | 1.01957% |
| | 11 | 2 BdRm-C | 1223 | 0.84885% |
| | 12 | 2 BdRm-D | 1300 | 0.90227% |
| | 13 | 3 BdRm-A | 1405 | 0.97515% |
| | 14 | 2 BdRm-C | 1223 | 0.84885% |
| | 15 | 2 BdRm-D | 1300 | 0.90227% |
| Building 3: | 16 | 3 BdRm-F | 1469 | 1.01957% |
| | 17 | 3 BdRm-A | 1405 | 0.97515% |
| | 18 | 2 BdRm-C | 1223 | 0.84885% |
| | 19 | 3 BdRm-A | 1405 | 0.97515% |
| | 20 | 2 BdRm-D | 1300 | 0.90227% |
| | 21 | 3 BdRm-F | 1469 | 1.01957% |
| | 22 | 2 BdRm-C | 1223 | 0.84885% |
| | 23 | 2 BdRm-D | 1300 | 0.90227% |
| | 24 | 3 BdRm-A | 1405 | 0.97515% |
| | 25 | 2 BdRm-C | 1223 | 0.84885% |
| 26 | 2 BdRm-D | 1300 | 0.90227% | |
| Building 4: | 27 | 2 BdRm-D | 1300 | 0.90227% |
| | 28 | 2 BdRm-C | 1223 | 0.84885% |
| | 29 | 3 BdRm-A | 1405 | 0.97515% |
| | 30 | 2 BdRm-D | 1300 | 0.90227% |
| | 31 | 2 BdRm-C | 1223 | 0.84885% |
| | 32 | 3 BdRm-F | 1469 | 1.01957% |
| | 33 | 2 BdRm-D | 1300 | 0.90227% |
| | 34 | 3 BdRm-A | 1405 | 0.97515% |

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|--------------|----|----------|------|----------|
| | 35 | 2 BdRm-C | 1223 | 0.84885% |
| | 36 | 3 BdRm-A | 1405 | 0.97515% |
| | 37 | 3 BdRm-A | 1405 | 0.97515% |
| | 38 | 2 BdRm-D | 1300 | 0.90227% |
| | 39 | 2 BdRm-C | 1223 | 0.84885% |
| | 40 | 3 BdRm-F | 1469 | 1.01957% |
| | 41 | 3 BdRm-F | 1469 | 1.01957% |
| Building 5: | 42 | 2 BdRm-D | 1300 | 0.90227% |
| | 43 | 2 BdRm-C | 1223 | 0.84885% |
| | 44 | 3 BdRm-A | 1405 | 0.97515% |
| | 45 | 2 BdRm-D | 1300 | 0.90227% |
| | 46 | 2 BdRm-C | 1223 | 0.84885% |
| | 47 | 3 BdRm-F | 1469 | 1.01957% |
| | 48 | 3 BdRm-A | 1405 | 0.97515% |
| | 49 | 3 BdRm-F | 1469 | 1.01957% |
| Building 6: | 50 | 3 BdRm-F | 1469 | 1.01957% |
| | 51 | 3 BdRm-A | 1405 | 0.97515% |
| | 52 | 2 BdRm-C | 1223 | 0.84885% |
| | 53 | 3 BdRm-A | 1405 | 0.97515% |
| | 54 | 2 BdRm-D | 1300 | 0.90227% |
| | 55 | 3 BdRm-F | 1469 | 1.01957% |
| | 56 | 2 BdRm-C | 1223 | 0.84885% |
| | 57 | 2 BdRm-D | 1300 | 0.90227% |
| | 58 | 3 BdRm-A | 1405 | 0.97515% |
| | 59 | 2 BdRm-C | 1223 | 0.84885% |
| | 60 | 2 BdRm-D | 1300 | 0.90227% |
| Building 7A: | 61 | 3 BdRm-F | 1469 | 1.01957% |
| | 62 | 2 BdRm-D | 1300 | 0.90227% |
| | 63 | 3 BdRm-A | 1405 | 0.97515% |
| | 64 | 2 BdRm-D | 1300 | 0.90227% |
| | 65 | 2 BdRm-D | 1300 | 0.90227% |
| Building 7B: | 67 | 3 BdRm-F | 1469 | 1.01957% |
| | 68 | 2 BdRm-D | 1300 | 0.90227% |
| | 69 | 3 BdRm-A | 1405 | 0.97515% |
| | 70 | 2 BdRm-D | 1300 | 0.90227% |
| | 71 | 2 BdRm-D | 1300 | 0.90227% |
| Building 8: | 72 | 3 BdRm-F | 1469 | 1.01957% |
| | 73 | 3 BdRm-A | 1405 | 0.97515% |
| | 74 | 2 BdRm-C | 1223 | 0.84885% |
| | 75 | 3 BdRm-A | 1405 | 0.97515% |
| | 76 | 2 BdRm-D | 1300 | 0.90227% |

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|--------------|-----|----------|------|----------|
| | 77 | 3 BdRm-F | 1469 | 1.01957% |
| | 78 | 2 BdRm-C | 1223 | 0.84885% |
| | 79 | 2 BdRm-D | 1300 | 0.90227% |
| | 80 | 3 BdRm-A | 1405 | 0.97515% |
| | 81 | 2 BdRm-C | 1223 | 0.84885% |
| | 82 | 2 BdRm-D | 1300 | 0.90227% |
| Building 9B: | 83 | 3 BdRm-F | 1469 | 1.01957% |
| | 84 | 2 BdRm-D | 1300 | 0.90227% |
| | 85 | 2 BdRm-G | 1370 | 0.95086% |
| | 86 | 2 BdRm-D | 1300 | 0.90227% |
| | 87 | 3 BdRm-F | 1469 | 1.01957% |
| Building 9A: | 89 | 3 BdRm-F | 1469 | 1.01957% |
| | 90 | 2 BdRm-D | 1300 | 0.90227% |
| | 91 | 3 BdRm-A | 1405 | 0.97515% |
| | 92 | 2 BdRm-D | 1300 | 0.90227% |
| | 93 | 2 BdRm-D | 1300 | 0.90227% |
| Building 10: | 94 | 3 BdRm-F | 1469 | 1.01957% |
| | 95 | 3 BdRm-A | 1405 | 0.97515% |
| | 96 | 3 BdRm-F | 1469 | 1.01957% |
| | 97 | 2 BdRm-C | 1223 | 0.84885% |
| | 98 | 2 BdRm-D | 1300 | 0.90227% |
| | 99 | 3 BdRm-A | 1405 | 0.97515% |
| | 100 | 3 BdRm-C | 1223 | 0.84885% |
| | 101 | 2 BdRm-D | 1300 | 0.90227% |
| Building 11: | 102 | 3 BdRm-F | 1469 | 1.01957% |
| | 103 | 3 BdRm-A | 1405 | 0.97515% |
| | 104 | 3 BdRm-F | 1469 | 1.01957% |
| | 105 | 2 BdRm-C | 1223 | 0.84885% |
| | 106 | 2 BdRm-D | 1300 | 0.90227% |
| | 107 | 3 BdRm-A | 1405 | 0.97515% |
| | 108 | 3 BdRm-C | 1223 | 0.84885% |
| | 109 | 2 BdRm-D | 1300 | 0.90227% |

** Approximate Percentages